WATER SOURCE HEAT PUMP CONTROL SYSTEM NOTES:

PROVIDE UNITS COMPLETE WITH CONTROLS, FLEXIBLE COLLARS, <u>VIBRATION ISOLATION SPRINGS</u>, COMPRESSOR SOUND BLANKETS, BALANCING VALVES, PROGRAMMABLE THERMOSTATS/SENSORS WITH PROGAMMABLE FAN CYCLE, 30% EFFICIENT FILTERS, AUTOMATIC BALANCE VALVE KIT, LOW PRESSURE REFRIGERANT SWITCH, LEVEL-SENSITIVE FLOAT SWITCH IN CONDENSATE PAN AND STANDARD EQUIPMENT AS PROVIDED BY TRANE OR APPROVED EQUAL.

- UNITS SHALL HAVE HIGH INTENSITY UV-C GERMICIDAL LAMP INSTALLED IN RETURN OR SUPPLY DUCTWORK PER MANUFACTURER. THE CONDENSER WATER LOOP TEMPERATURE, COOLING TOWER, 3–WAY VALVES, BOILER CONTROL &PUMP OPERATIONS SHALL BE MONITORED/ALARMED BY THE WATTMASTER WHP CONTROL SYSTEM OR EQUAL THE SYSTEM
- SHALL BE MODULAR & PROVIDE SENSORS, ACTUATORS, DDC CONTROLLERS AND OPERATORS FOR A COMPLETE AND AUTOMATIC OPERATING WATER SOURCE HEAT PUMP SYSTEM. PROVIDE A REMOTE PANEL
- WITH AUDIBLE AND VISIBLE ALARMS IN OWNER DESIGNATED OFFICE TO NOTIFY OWNER OF MALFUNCTIONS. OBTAIN THE SERVICES OF AN APPROVED AND 5 YEARS EXPERIENCED CONTROLS ENGINEER OR CONTRACTOR.
- CONTRACTOR TO DESIGN AND INSTALL A CENTRAL CONTROL SYSTEM FOR THE HEAT PUMP UNITS, BOILER, CONDENSER WATER PUMPS, BOILER CIRCULATOR PUMPS, ALL CONTROL VALVES, ROOM THERMOSTAT/SENSORS AND COOLING TOWER SYSTEM. CENTRAL CONTROL/MONITORING SYSTEM SHALL PROVIDE AS A MINIMUM CRITICIAL CONTROL STATUS AND ALARMS
- FOR THE HEATING AND AIR CONDITIONING EQUIPMENT. PROVIDE WATTMASTER WATER SOURCE HEAT PUMP CONTROL SYSTEM OR APPROVED BY OWNER/ENGINEER EQUAL. CONTROLS CONTRACTOR SHALL PROVIDE A COMPLETE WATER SOURCE HEAT PUMP CONTROL SYSTEM WHICH CAN
- RESET AND CHANGE ALL OPERATIONS OF THE CRITICAL HVAC EQUIPMENT FROM A CENTRAL COMPUTER WITH PRINTER AND MONITOR. SYSTEM SHALL HAVE CAPABILITY TO SIGNAL THE SECURITY SYSTEM OR REMOTE DIALED NUMBER WHEN THERE IS A PROBLEM WITH ANY CRITICAL HVAC EQUIPMENT. AS A MINIMUM, THE SYSTEM SHALL MONITOR AND CONTROL. WATER SOURCE HEAT PUMP UNITS, CONDENSER WATER PUMPS, BOILER HOT WATER PUMPS,
- BOILERS, WATER TEMPERATURE SETPOINT AND RESET ON CONDENSER WATER LOOP AND BOILER HOT WATER LOOP.

COOLING TOWER OPERATION, ROOM TEMPERATURE SENSORS SET AND RESET POINTS, OUTSIDE AIR TEMPERATRE SET POINTS AND STATUS, MODULATING OUTSIDE AIR DAMPER SETPOINT.

TABLE 1 STEEL PIPE HANGER & ROD SCHEDULE

MINIMUM ROD SIZES & MAXIMUM SPACING FOR INSTALLING HANGERS FOR STEEL DISTRIBUTION PIPING, MSS SP-69 TABLE 3

NOM. PIPE SIZE (INCHES)	STEEL PIPE MAX. SPAN-FT (FEET)	MIN. ROD SIZES (INCHES)		
1/2	7	3/8		
3/4	7	3/8		
1	7	3/8		
1-1/4	7	3/8		
1-1/2	9	3/8		
2	10	3/8		
2-1/2	11	1/2		
3	12	1/2		
4	14	5/8		
5	16	5/8		
6	17	3/4		
8	19	7/8		
10	22	7/8		
12	23	7/8		

TABLE COPPER TYPE "L" PIPE HANGER & ROD SCHEDULE

MINIMUM ROD SIZES & MAXIMUM SPACING FOR INSTALLING HANGERS FOR COPPER TYPE "L" DISTRIBUTION PIPING PER MSS SP-69NOM. PIPE SIZE (INCHES)COPPER PIPE MAX. SPAN-FT (FEET)MIN. ROD SIZES (INCHES)1/253/83/453/8163/8163/81-1/473/81-1/283/8283/8				
NOM. FIFE SIZE (INCHES) MAX. SPAN-FT (FEET) MIN. ROD SIZES (INCHES) 1/2 5 3/8 3/4 5 3/8 1 6 3/8 1-1/4 7 3/8 1-1/2 8 3/8				
$\begin{array}{c ccccccccccccccccccccccccccccccccccc$			MAX. SPAN-FT	
1 6 3/8 1-1/4 7 3/8 1-1/2 8 3/8		1/2	5	3/8
1-1/4 7 3/8 1-1/2 8 3/8		3/4	5	3/8
1-1/2 8 3/8		1	6	3/8
		1-1/4	7	3/8
2 8 3/8		1-1/2	8	3/8
		2	8	3/8

STEEL ROD PER SCHEDULE GALVANIZED OR ELECTRO-PLATED - STANDARD CLEVIS PIPE HANGER, MSS SP-69, TYPE I RIGID INSULATION IN LOWER HALF OF PIPE PER MFR. NEW INSULATION PROTECTION SHIELD, MSS SP-69 TYPE 40 LENGTH & THICKNESS PER SCHEDULE


CLEVIS HANGER SUPPORT

FOR INSULATED PIPE N.T.S.

INSULATED PIPING SHIELD SCHEDULE

NPS (INCHES)	LENGTH (INCHES)	THICKNESS (INCHES)
1/4 TO 3-1/2	12	18 GA. (0.048)
4	12	16 GA. (0.060)
5 & 6	18	16 GA. (0.060)
8 TO 14	24	14 GA. (0.075)
16 TO 24	24	12 GA. (0.105)

OTHER PIPE MATERIALS FOLLOW MSS SP-69 TABLE 5

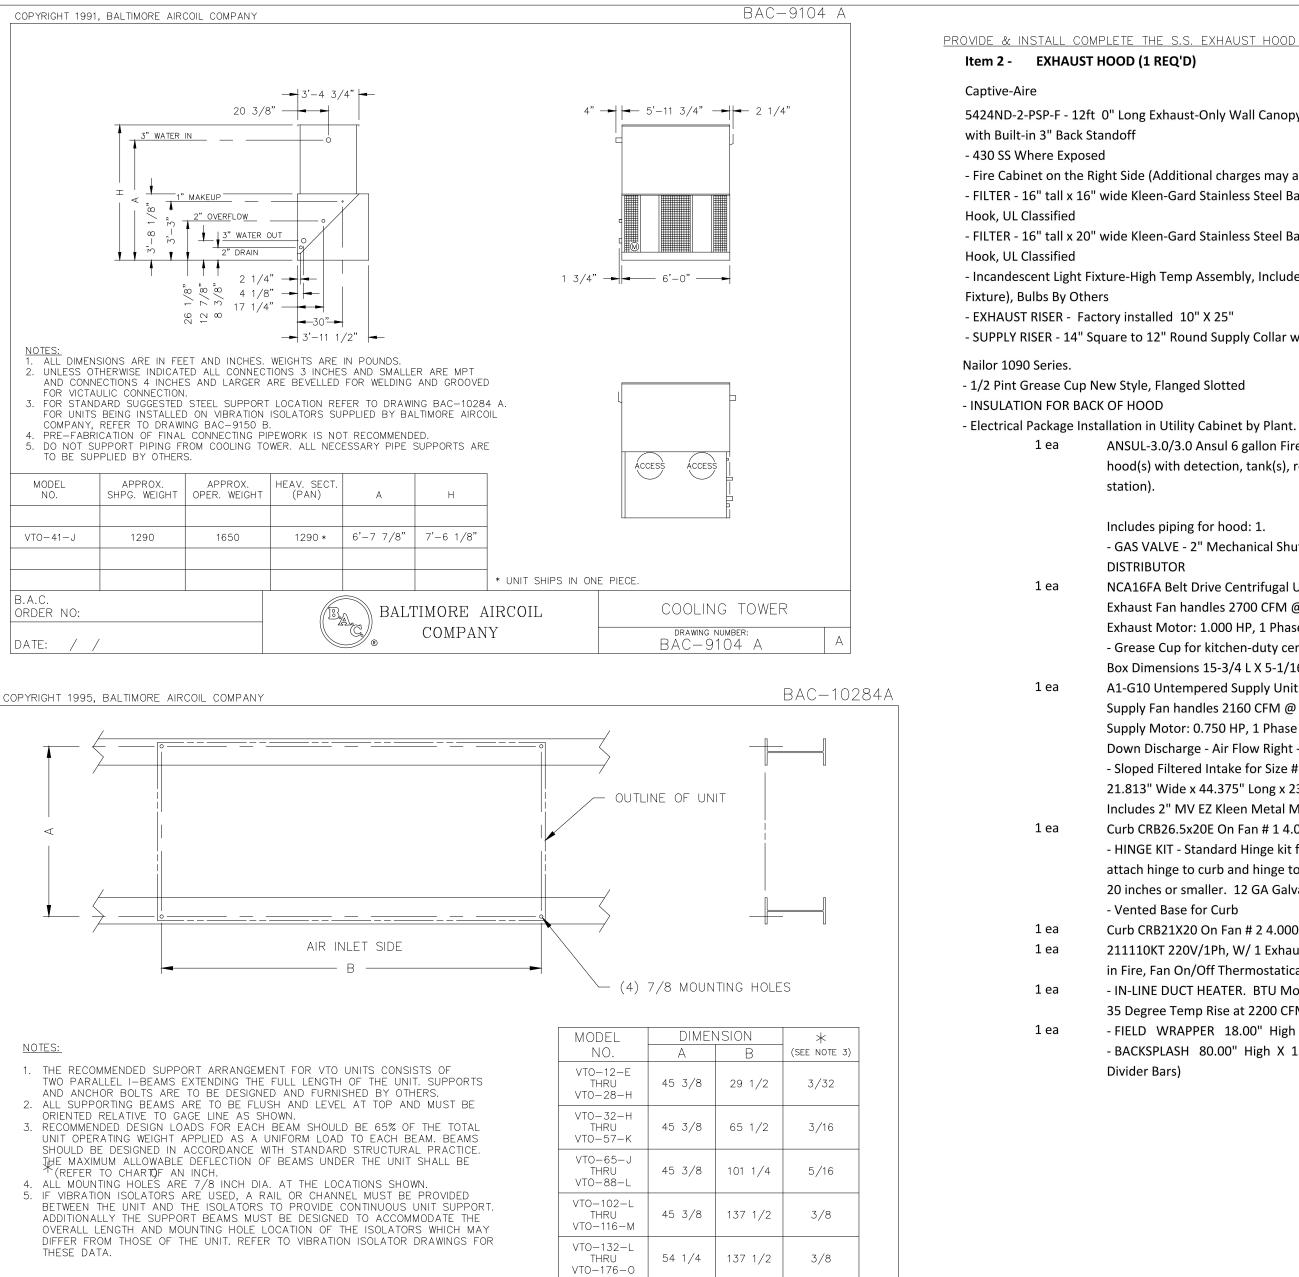

54 1/4 | 137 1/2 |

3/8

B.A.C. ORDER NO:	BALTIMORE AIRCOIL	SUGGSETED STEEL SUPPORT VTO-12-E THRU VTO-176-0
DATE: / /	COMPANY ®	drawing number: BAC—10284A

PROVIDE & INSTALL COMPLETE THE S.S. EXHAUST HOOD AS FOLLOWS:

5424ND-2-PSP-F - 12ft 0" Long Exhaust-Only Wall Canopy Hood with Front Perforated Supply Plenum

- Fire Cabinet on the Right Side (Additional charges may apply for cabinet if not sold with fire system) - FILTER - 16" tall x 16" wide Kleen-Gard Stainless Steel Baffle Filter with Handles and Bottom Hanging

- FILTER - 16" tall x 20" wide Kleen-Gard Stainless Steel Baffle Filter with Handles and Bottom Hanging

- Incandescent Light Fixture-High Temp Assembly, Includes Clear Thermal and Shock Resistant Globe (L55

- SUPPLY RISER - 14" Square to 12" Round Supply Collar with 12" Round Volume Damper.

ANSUL-3.0/3.0 Ansul 6 gallon Fire System in Utility Cabinet (includes pre-piped hood(s) with detection, tank(s), release mechanism, microswitches and pull station).

Includes piping for hood: 1.

- GAS VALVE - 2" Mechanical Shutoff Valve (Ansul)(28-55610); SUPPLIED BY DISTRIBUTOR

NCA16FA Belt Drive Centrifugal Upblast Exhaust Fan with 18.75" wheel Exhaust Fan handles 2700 CFM @ -1.000" wc ESP, Fan runs at 1020 RPM. Exhaust Motor: 1.000 HP, 1 Phase 230 V, 60Hz, 6.8 FLA, ODP (Open Drip Proof) - Grease Cup for kitchen-duty centrifugal exhaust fans,

Box Dimensions 15-3/4 L X 5-1/16 W X 3-3/4 H (18 GA.) (Includes Down Spout) A1-G10 Untempered Supply Unit with 10" Blower in Size #1 Housing

Supply Fan handles 2160 CFM @ 0.375" wc ESP, Fan runs at 752 RPM. Supply Motor: 0.750 HP, 1 Phase 230 V, 60Hz, 5.4 FLA, ODP (Open Drip Proof) Down Discharge - Air Flow Right -> Left

- Sloped Filtered Intake for Size #1 Modular Untempered Supply Unit.

21.813" Wide x 44.375" Long x 23.375" High. Includes 2" MV EZ Kleen Metal Mesh Filters.

Curb CRB26.5x20E On Fan # 1 4.000:12.000 Pitch

- HINGE KIT - Standard Hinge kit for exhaust fan roof curbs. Includes Hardware to attach hinge to curb and hinge to base. Ships Loose. Used on Fans with wheels

20 inches or smaller. 12 GA Galvanized. - Vented Base for Curb

Curb CRB21X20 On Fan # 2 4.000:12.000 Pitch

211110KT 220V/1Ph, W/ 1 Exhaust Fan, 1 Supply Fan, Exhaust in Fire, Lights out in Fire, Fan On/Off Thermostatically Controlled. Includes1 Duct Thermostat - IN-LINE DUCT HEATER. BTU Model MR-1624-21-1@240V.

35 Degree Temp Rise at 2200 CFM

- FIELD WRAPPER 18.00" High Front, Left, Right

- BACKSPLASH 80.00" High X 156.00" Long 430 SS (Includes End Caps & Divider Bars)

NORTH (magnetic)



Charles Washington Hall

RENOVATIONS Corner of George & Washington Streets Charles Town, W.Va.

For the **City of Charles Town** City of Ranson

Planning & Engineering (prime) Hall Planning & Engineering, Inc 316 Williams Street Tallahassee, FL 32303

Landscape Architecture Stromberg/Garrigan & Assoc., Inc. 102 E. Main Street-The Penn Bldg Somerset, PA 15501

Historic Preservation & Architecture Landmarks SGA, LLC 102 E. Main Street-The Penn Bldg Somerset, PA 15501

Structural Engineer


R.L. Silman Associates 1053 31st Street NW Washington D.C. 20007

Mech/Elect Engineer Comfort Design, Inc. 620 Pennsylvania Avenue Winchester, VA 22601

Architect



220 WEST KING • MARTINSBURG, WEST VIRGINIA • 25401

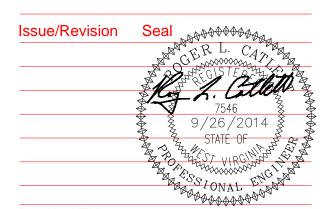

Drawing Title

Mechanical Schedules & Details

Date 9/26/14 Scale: As Shown Project Number 11105 **Drawing Number**

M1.2