


Attic & Roof Level Condenser Water Piping Plan

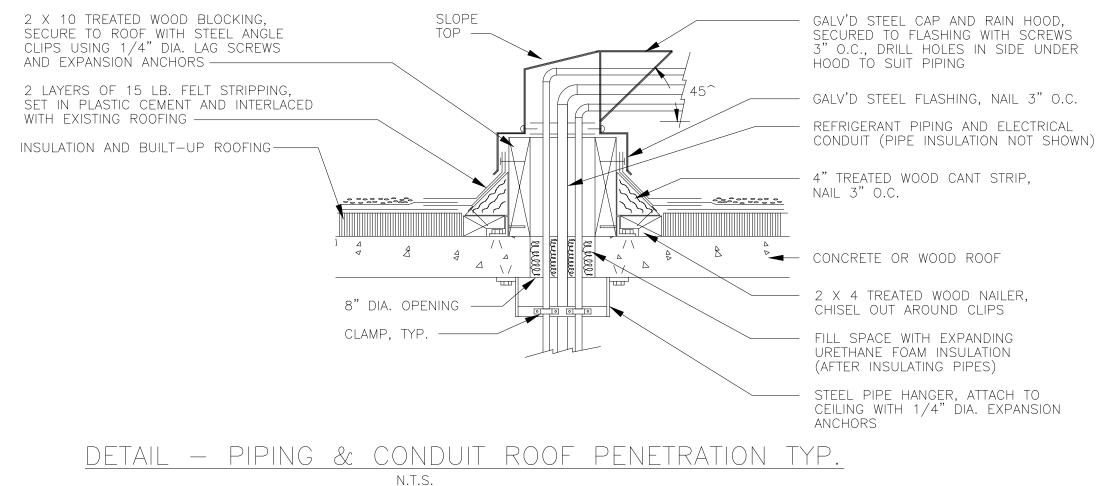

INSTALLATION SEQUENCE

1. CORE DRILL THE HOLE THROUGH THE ROOF.
2. INSTALL THE BLOCKING, CANT, ROOFING, AND FLASHING AS INDICATED.

INSTALL THE BLOCKING, CANT, ROOFING, AND FLASHING AS INDICATED.
 INSTALL THE PIPE HANGER SUPPORT.
 INSTALL THE VERTICAL SECTIONS OF THE NEW PIPES AND PROVIDE AN ELBOW AND A SHORT LENGTH OF HORIZONTAL PIPING ON EACH PIPE.
 INSULATE THE INSTALLED SUCTION LINE REFRIGERANT PIPE.
 INSTALL THE PORTION OF ELECTRICAL CONDUIT THAT WILL PASS THROUGH THE NEW ROOF OPENING AND HOODED FLASHING CAP.

7. DRILL THREE SEPARATE HOLES IN THE HOODED FLASHING CAP FOR THE TWO PIPES AND ONE ELECTRICAL CONDUIT.

8. INSTALL THE HOODED FLASHING CAP.
9. CAULK AROUND THE PIPE AND CONDUIT HOLES IN THE CAP AND ALSO ALL FLASHING SEAMS.
10. SPRAY URETHANE FOAM INSULATION IN THE VOID SPACE AROUND THE PIPES IN THE HOLE THROUGH THE ROOF.

11. INSTALL REMAINING PIPING AND CONDUIT.

NORTH (magnetic)



Charles Washington Hall

RENOVATIONS

Corner of George & **Washington Streets** Charles Town, W.Va.

For the City of Charles Town City of Ranson

Planning & Engineering (prime)

Hall Planning & Engineering, Inc 316 Williams Street

Tallahassee, FL 32303

Landscape Architecture

Stromberg/Garrigan & Assoc.,Inc. 102 E. Main Street-The Penn Bldg Somerset, PA 15501

Historic Preservation & Architecture Landmarks SGA, LLC 102 E. Main Street-The Penn Bldg Somerset, PA 15501

Structural Engineer


R.L. Silman Associates 1053 31st Street NW Washington D.C. 20007

Mech/Elect Engineer

Comfort Design, Inc. 620 Pennsylvania Avenue Winchester, VA 22601

Architect



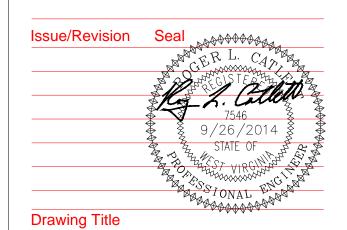

Attic & Roof Level Condenser Water Piping Plan

Date 9/26/14 Scale 1/4"=1'0" Project Number 11105 **Drawing Number**

M3.4