


First Floor Water Piping Plan
Scale: 1/4" = 1'0"

GEORGE STREET


Existing sidewalk entrance door to remain.

LP GAS SCHEDULE:
OVEN/BURNERS = 268 MBH
FRYERS 2 X 90 MBH = 180 MBH
HOT WATER HEATERS = 100 MBH
TOTAL LP GAS LOAD = 548 MBH

TABLE 402.4(26) INTERNATIONAL FUEL GAS CODE - 548 MBH AT 50 FEET TOTAL LENGTH, 11 W.C. & 0.5"W.C. DROP.
PROVIDE & INSTALL LP GAS AS SHOWN.

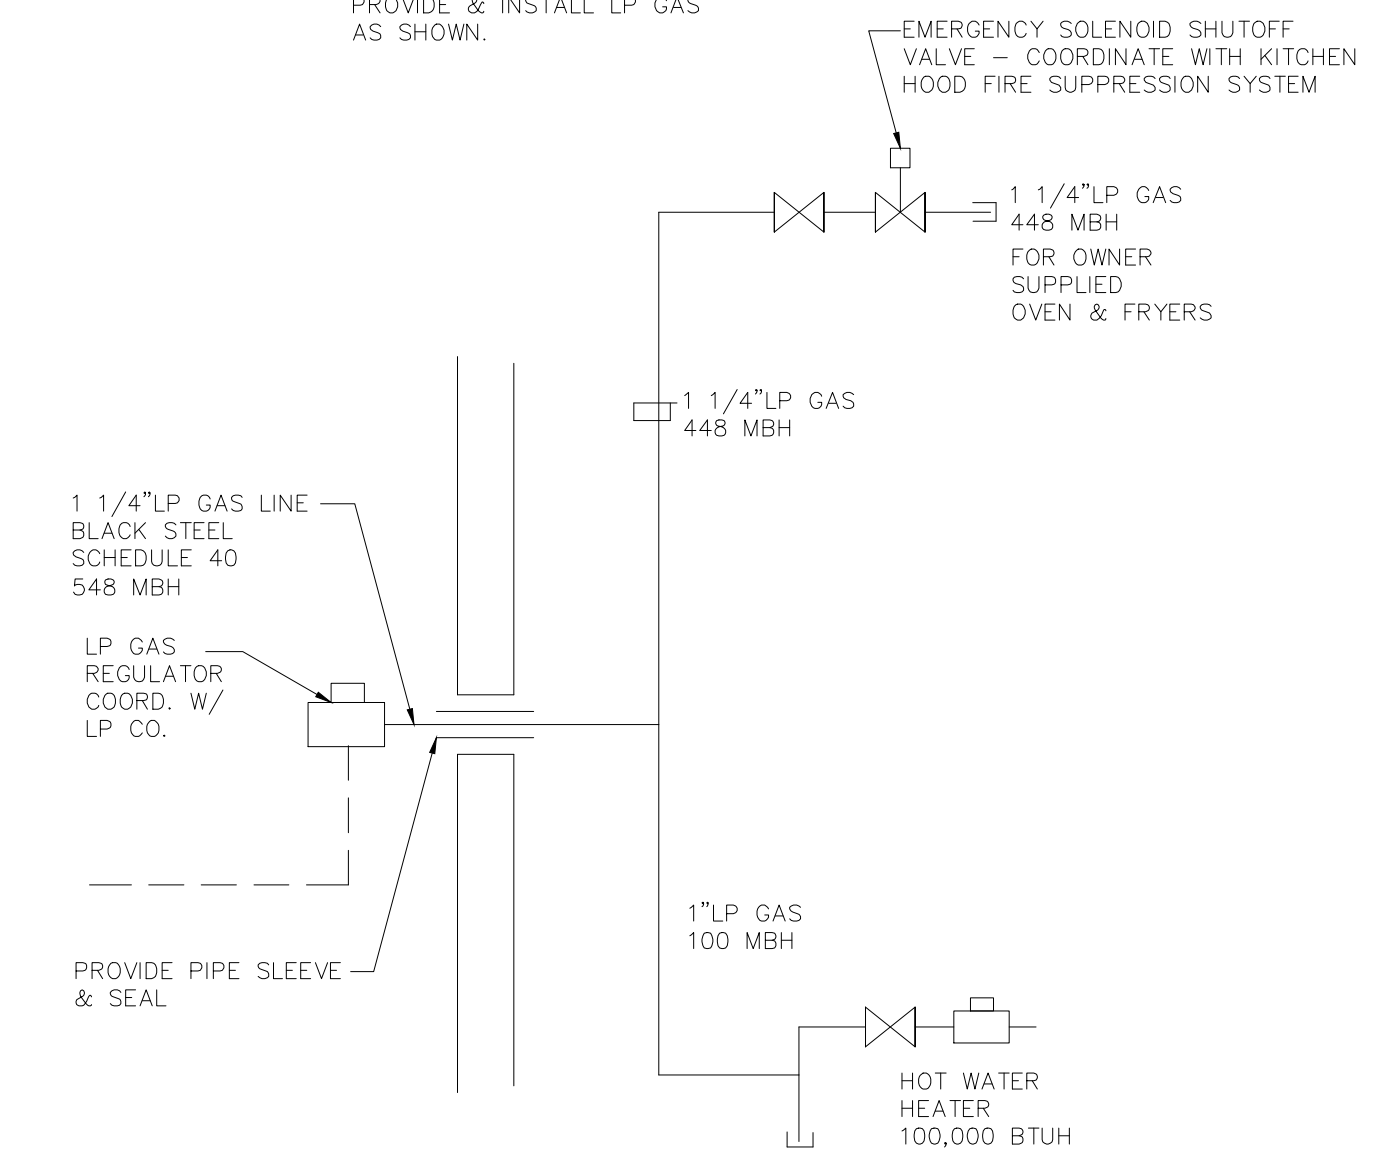

LP GAS RISER DIAGRAM
NOT-TO-SCALE

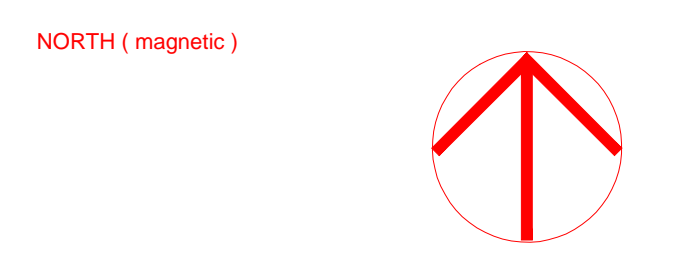

Charles Washington Hall
RENOVATIONS
Corner of George & Washington Streets
Charles Town, W.Va.

For the
City of Charles Town
City of Ranson

Planning & Engineering (prime)
Hall Planning & Engineering, Inc
316 Williams Street
Tallahassee, FL 32303

Landscape Architecture
Stromberg/Garrigan & Assoc., Inc.
102 E. Main Street-The Penn Bldg
Somerset, PA 15501

Historic Preservation & Architecture
Landmarks SGA, LLC
102 E. Main Street-The Penn Bldg
Somerset, PA 15501

Structural Engineer
R.L. Silman Associates
1053 31st Street NW
Washington D.C. 20007

Mech/Elect Engineer
Comfort Design, Inc.
620 Pennsylvania Avenue
Winchester, VA 22601

Architect
GROVE & DALL'OLIO ARCHITECTS^{PLLC}
220 WEST KING • MARTINSBURG, WEST VIRGINIA • 25401

Issue/Revision Seal

Drawing Title

First Floor Water & Gas Piping Plan
Date 9/26/14
Scale 1/4"=1'0" Project Number 11105
Drawing Number