



ROOF PLAN KEYED NOTES	
1	1-1/4" NATURAL GAS PIPE UP FROM BELOW. SEE "MECHANICAL EXTERIOR CROSS SECTION" ON SHEET M201 MECHANICAL DETAILS FOR ORIGINATION.
2	CONNECT NATURAL GAS PIPING TO MECHANICAL EQUIPMENT PER MANUFACTURER'S INSTALLATION INSTRUCTIONS. INCLUDE SHUT OFF VALVE AND DIRT LEG.
3	24x20 SA AND 24x20 RA DOWN FROM RTU-1 TO ATTIC SPACE. SEE M204 ENLARGED MECHANICAL ATTIC PLAN FOR CONTINUATION.
4	16x14 SA AND 16x14 RA DOWN FROM RTU-2 TO ATTIC SPACE. SEE SHEET M203 ENLARGED MECHANICAL ATTIC PLAN FOR CONTINUATION.

Revisions:	
No:	Date:
No:	Date:
No:	Date:
No:	Date:
No:	Date:

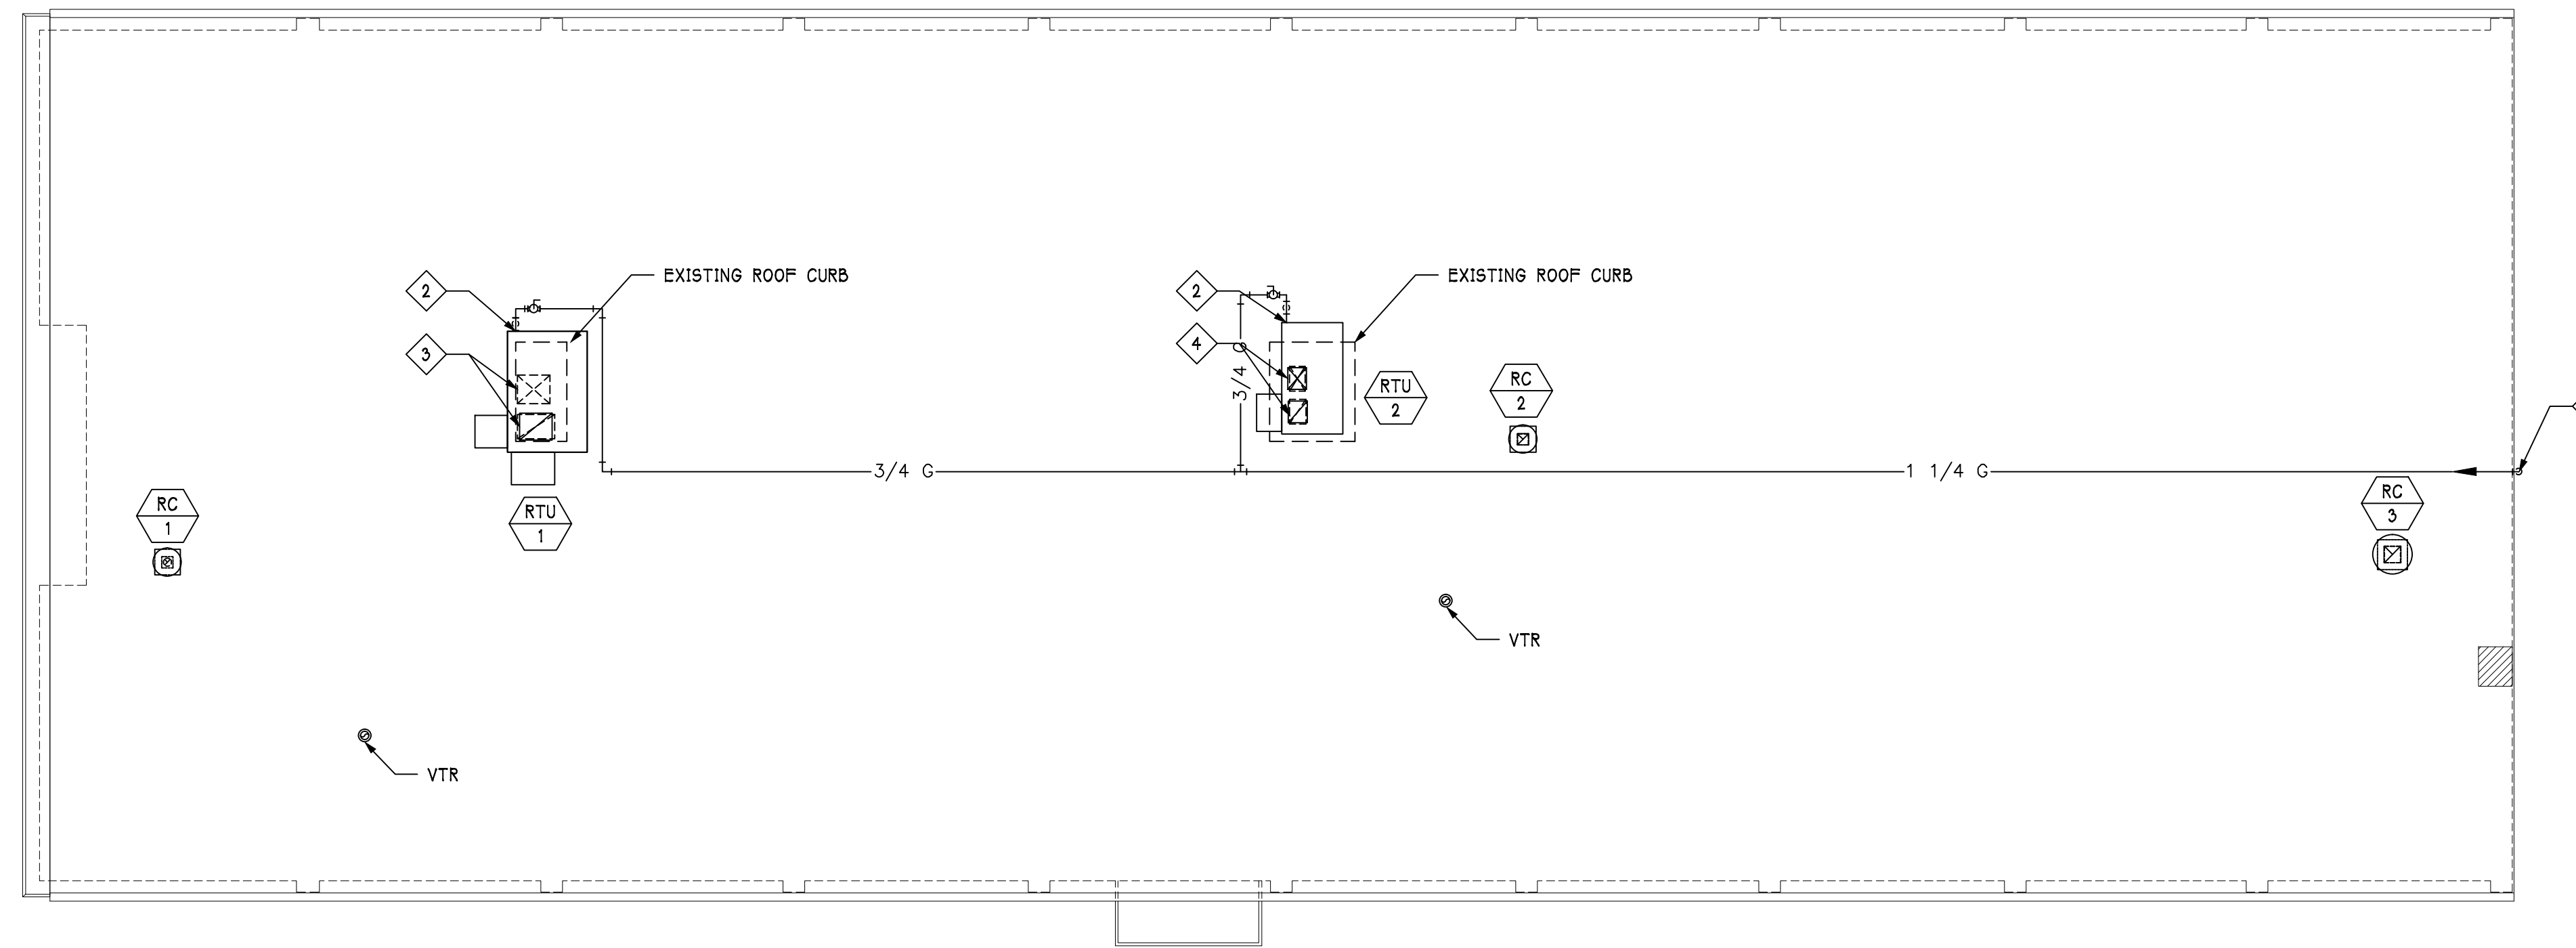

ROOF MECHANICAL PLAN
 1/8" = 1'-0"

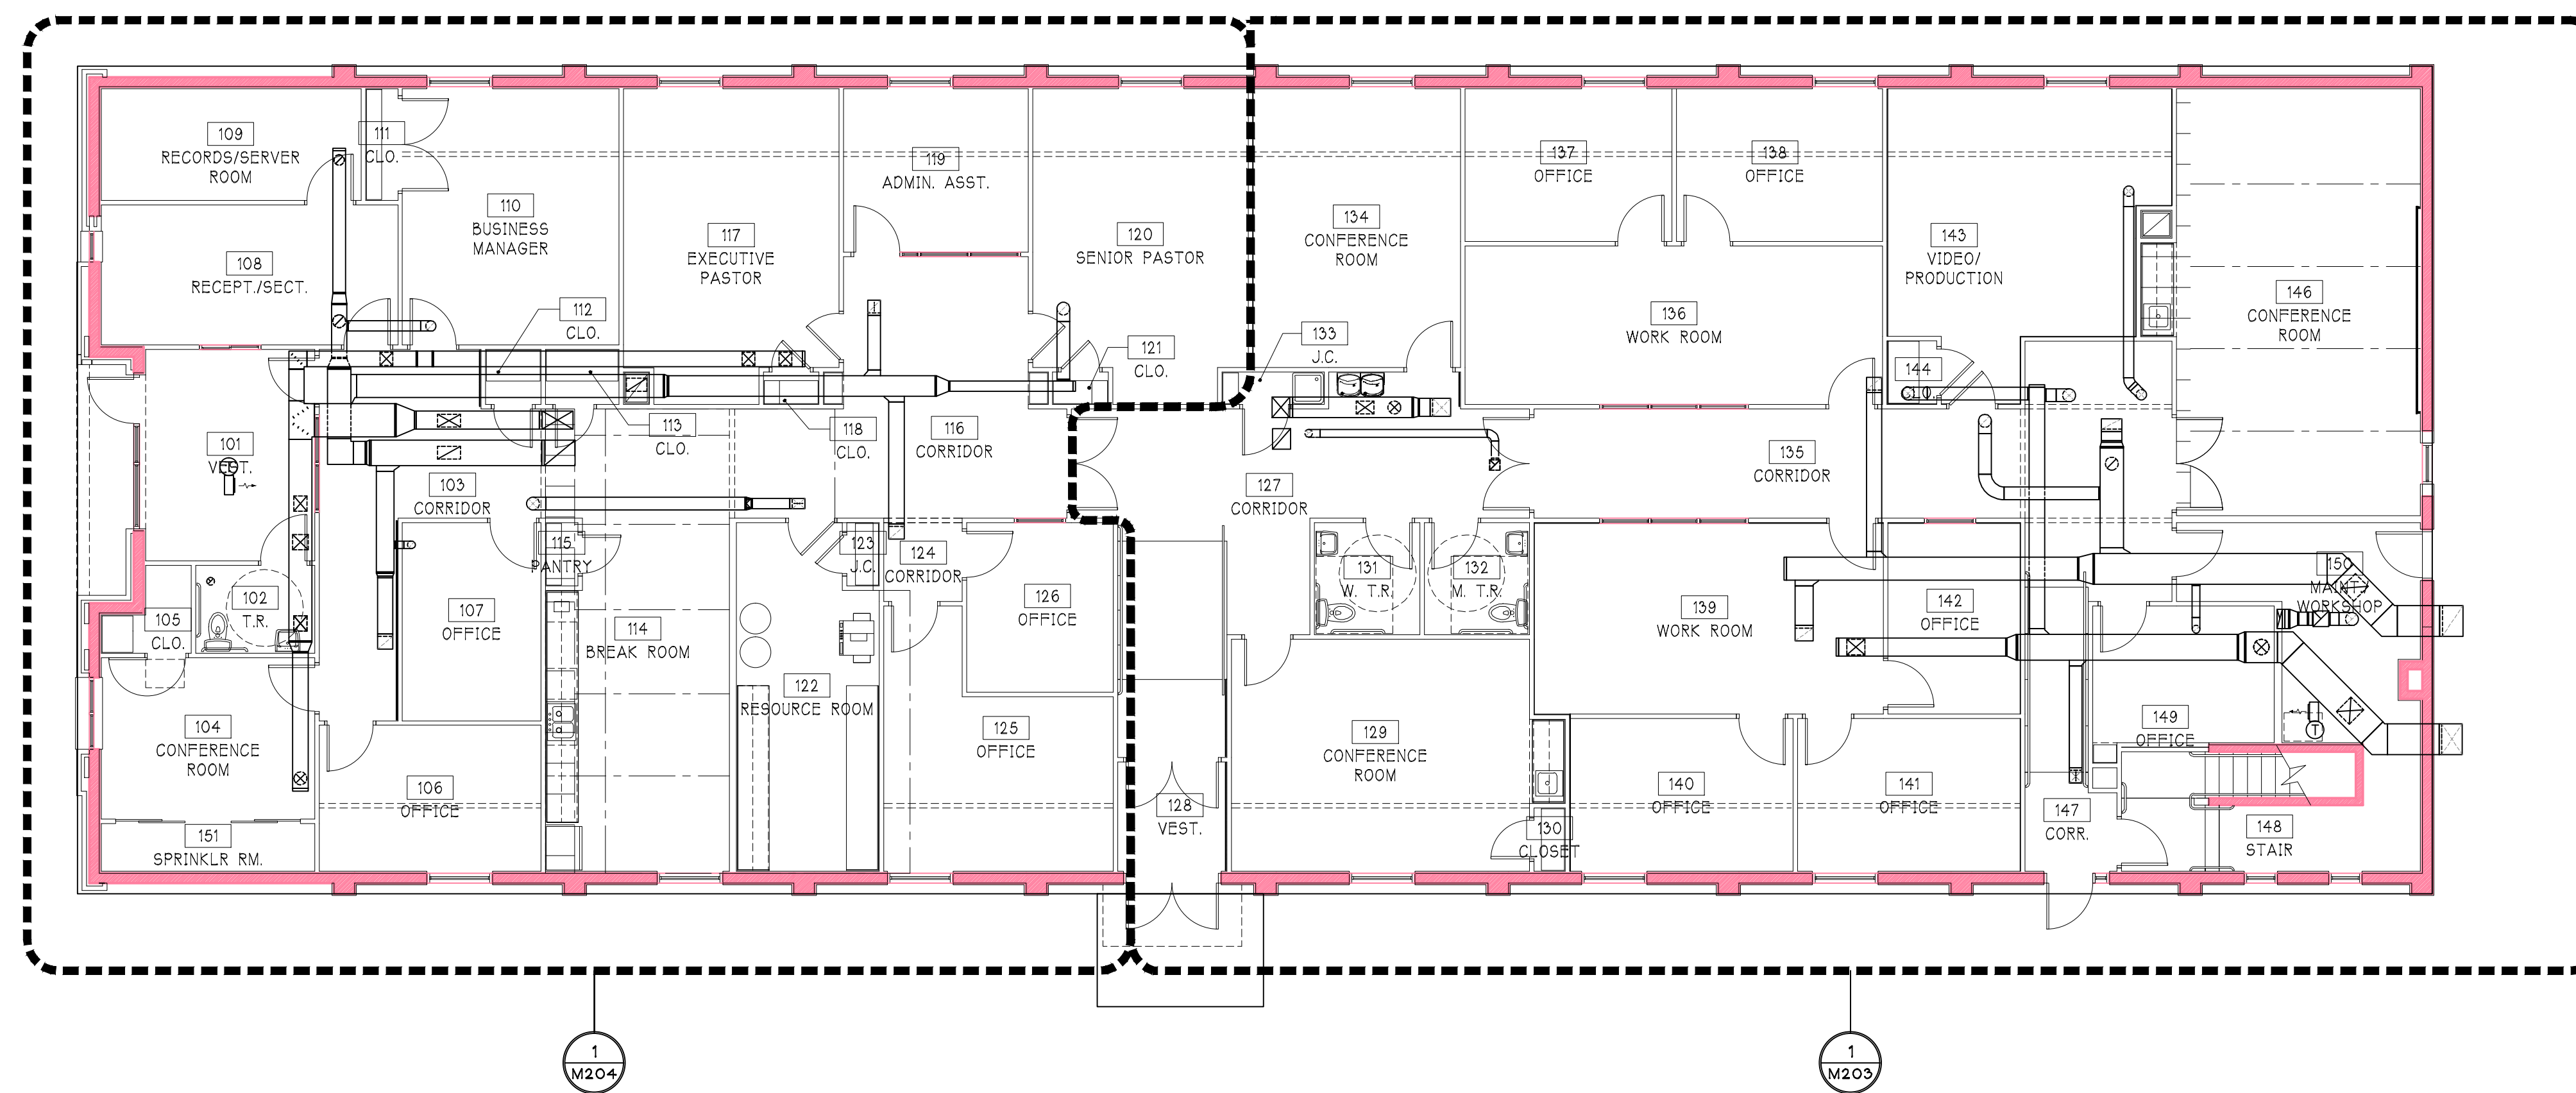

ATTIC MECHANICAL PLAN
 1/8" = 1'-0"

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 Office Building Renovation**

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Drawing Title:
 MECHANICAL PLANS

Sheet No.
M102
 Date: January 29, 2016